

Production Booklet

for

ASPIRE SPA

2800 Richter Ave. Suite C, Oroville, CA 95965 • voice: (530)534-9910 fax: (530)534-9915 • email: sales@tiledspas.com • website: www.tiledspas.com



RECOMMENDED MAINTENANCE

Please Note:

These are only recommended guidelines to care for a Nespa all tiled spa. Local codes may require additional procedures, therefore consult with a pool professional that is LA county Health Department ceritfied for more information on local codes and requirements.

SPA SURFACE

Your spa tile is acid resistant and frost-proof. The Tile does not absorb germs or algae. Tile does not stain and is very easy to clean. Color does not fade or loose its luster. All grouts are epoxy based and are extremely durable. To remove scum line use soft nylon brush and small amounts of biodegradable soaps. Do not use abrasive brushes or chemicals.

MAINTENANCE

A. CHEMICALS:

- 1) It is important to maintain a chlorine residual of 2 PPM in the spa. That residual can be provided by chlorine or bromine.
- 2) It is recommended to use Bromine or dichlor (granular) forms of chlorine. If bromine Tabs are used we suggest floating or inline dispenser.
- 3) Never use acid to lower Ph in the tile spa.
- 4) Never use trichlor chlorine (1" or 3") tablets in the Nespa spas.
- 5) Never place tablets in skimmer basket.

B. DRAINING THE SPA:

- 1) It is recommended to drain the spa at least once every 2 months depending on bath load and water clarity.
- 2) The spa should be drained through valve exiting re-circulation pump in the spa equipment room or sump pump.
- 3) Note: Use caution to drain spa in the winter months or rainy season when water table is at its highest. It is possible for the spa to float due to hydraulic pressure from surrounding water table. We advise that you consult with your local spa specialist prior to draining the spa.

C. SPA EQUIPMENT:


- 1) Clean filter cartridge at least once every month, or when needed; i.e., if water clarity does not improve after several days.
- 2) Keep area free and clear from leaves and debris build-up.
- 3) Keep area free and clear from flooding.

D. SPA LIGHT:

1) Spa light has to be on GFCI circuit. It is controlled at spa side with ON/OFF.

E. TILE SERVICING:


1) Contact manufacture when servicing tile or grout. @ (530) 534-9910

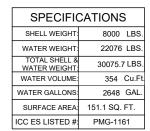

NESPA ENTERPRISES, Inc.

ICC ES Listed PMG-1161

Legacy 9' x 17' CS

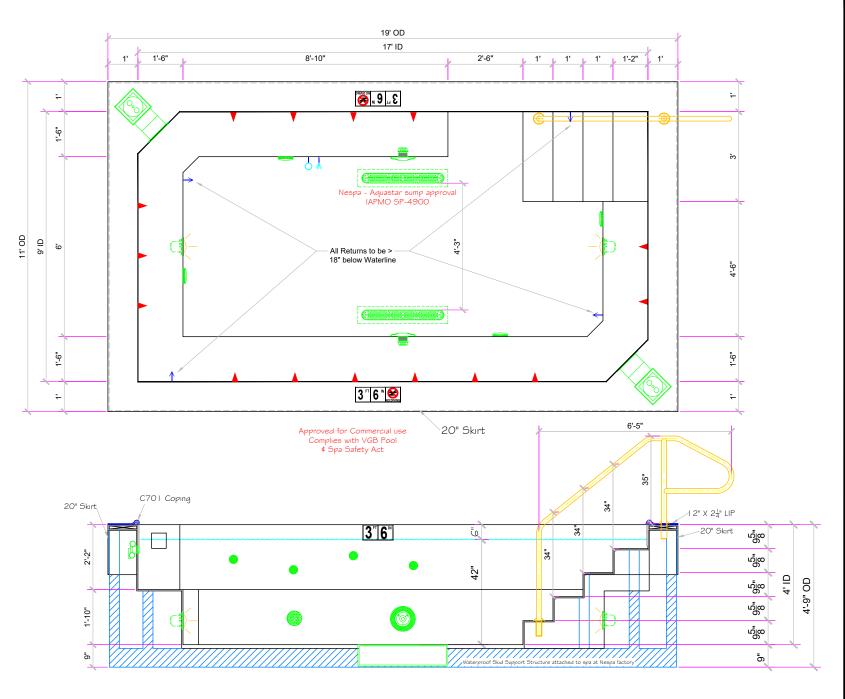

APPROVED


ALL DIMENSIONS SUBJECT TO 1/4" TOLERANCES

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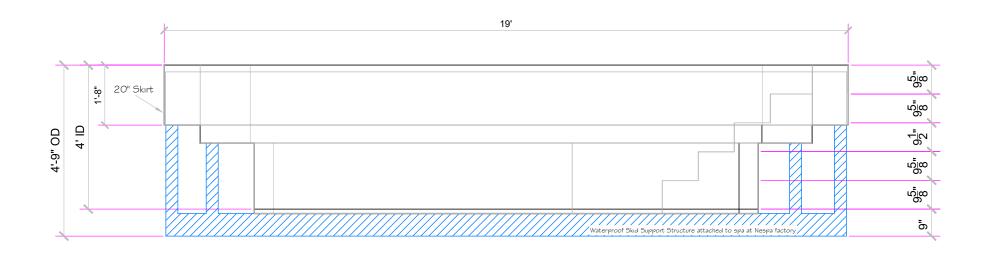
NESPA ENTERPRISES INC.


Office: (530) 534-9910 Fax: (530) 534-9915

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DWG TYPE SCALE 5/16" = 1' SPA SD 1/4 1/2 3/4 1" SHEET **PAGE 1 OF 10** 10/29/2018



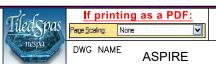

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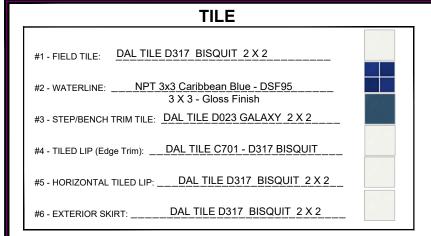
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SCALE 3/8" = 1' 1/4 1/2 3/4 1"

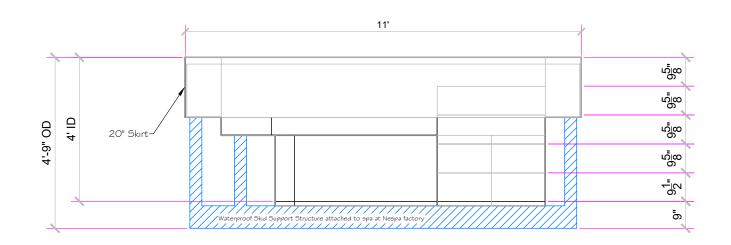DWG TYPE **SPA Elevations** SHEET

DATE **ASPIRE**

PAGE 2 OF 10 9/10/2018




GROUT


#1 - SPA Field Grout: Nespa Epoxy Grey mix of 200 & 164

#2 - SPA Waterline Grout: Nespa Epoxy Grey mix of 200 & 164

#3 - SPA Horizontal Lip Grout: Nespa Epoxy Grey mix of 200 & 164

DETAIL

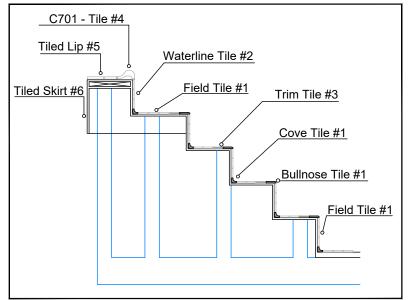


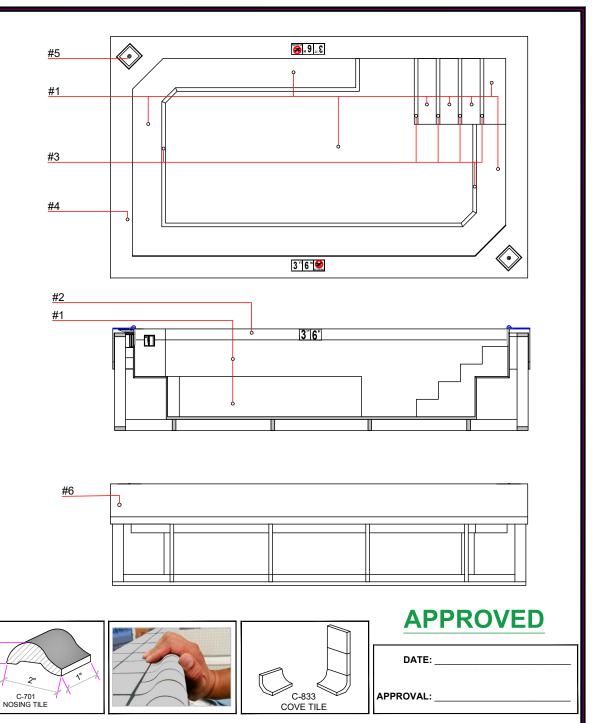

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SCALE

N/A


DWG TYPE 1/4 1/2 3/4 1"

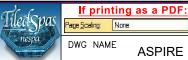SPA TILE

SHEET

9/28/2018 PAGE 3 OF 10

	EQUIPMENT LIST										
ITEM	CODE	EQUIPMENT	DESCRIPTION	MANUFACTURER	CATALOG NO.	QTY.					
1	SS		SURFACE SKIMMER - AUTOMATIC W/ EQUALIZER, NSF APPROVED	HAYWARD	SP-1084FVE	2					
2	BS		Paramount SDX 10" HIGH FLOW SAFETY DRAIN Area of Opening = 43.201 in/sq Velocity @ 200 GPM = 1.485 fps V.G.B Approved Safety Drain Complies w/ ANSI / ASME A112.19.8 & NSF / ANSI 16-2011	PARAMOUNT	SDX 004-182-2212-01	2					
3	MD		MAIN DRAIN: AQUASTAR 32CDFLFR, 32° CHANNEL DRAIN, Approved Max Flow Rate: Floor = 316 GPM @ 3.9 fps Complies wi ANSI / ASME A112.19.8 & NSF / ANSI 16-2011 - V.G.B.APPROVED	AQUASTAR	32CDFLFR101	2					
4	EQ		6 - Round Hockey puck- Sumpless Sucidon Outlet Floor 177 GPM - Wall 122 GPM Complies wi ANSI / ASME A112.19.8 & ANSI / APSF-16 for anti-hair and body entrapment Suction outlets comply with ANSI / APSP-7	AQUASTAR	6НРНАххх	4					
5	J#	•	HYDRO JETS 1-1/2" WATER - 1-1/2" AIR Complies w/ ANSI / ASME A112.19.8 & ANSI / APSF-16 - UL APPROVED	HYDROAIR	10-5100	15					
6	WI	\leftarrow	INLET FITTINGS 1-1/2" WALL TYPE W/ EYEBALL COMPLIES W/ ANSI CODE ASME A112.19.8-07 UL APPROVED	HYDROAIR	10-3500	4					
7	UL	(1)	LIGHT NICHE (FOR UNDERWATER LIGHT) W/ 1" HUB	PENTAIR	78242300	2					
8	HR	•	HAND RAIL, STAINLESS STEEL, 6' - 5" LENGTH,	CUSTOM	P-Rail	1					
9	CA	9	CUP ANCHOR: 6" BIG BOY SOCKET - USES PW-4C WEDGE	PERMA-CAST	PS-6019-BC	2					
10	РВ	400	POOL BOND	PERMA-CAST	PB-2008	1					

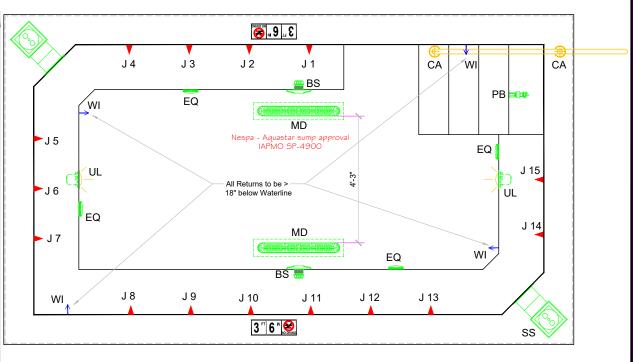

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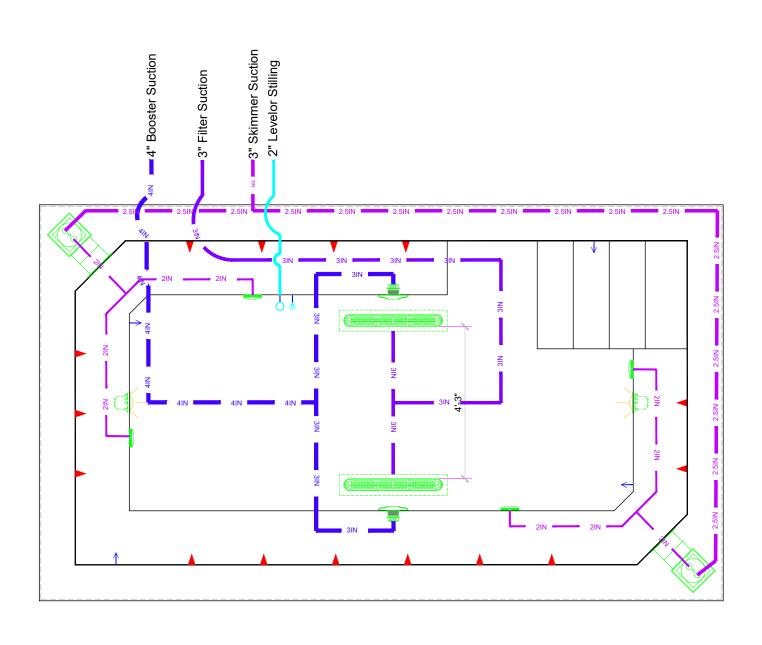


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SCALE 5/16" = 1' 1/4 1/2 3/4 1" 9/10/2018

DWG TYPE Spa EQ SHEET PAGE 4 OF 10




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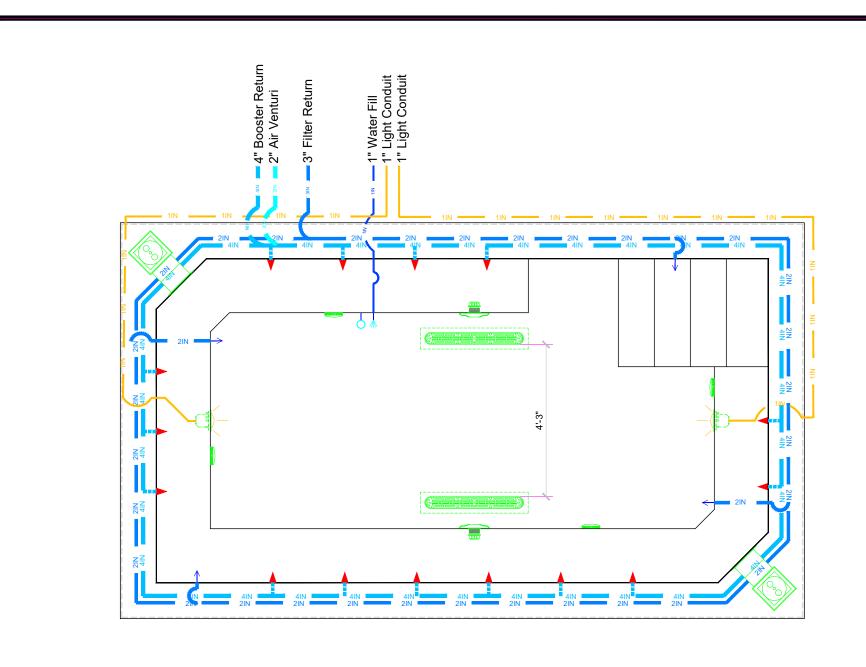
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9/28/2018

DWG TYPE Spa Suction Plumbing SHEET


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SCALE 3/8" = 1'


1/2 3/4 1" 1/4 9/28/2018

DWG TYPE Spa Return Plumbing SHEET

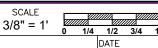PAGE 6 OF 10

SPA #33 18 Spa Skirt Tiled 32" Spa Skirt not Tiled 4 Booster Suction Filter Suction Filter Return <u>1</u>∞ 36" 30" **APPROVED** NESPA ENTERPRISES INC. These drawings, concepts, and details contained herein are the SCALE DWG TYPE If printing as a PDF: developed over many years of experience in the industry and as such are protected by the copyright laws of the United States Plumbing Layout (SPA) Page <u>S</u>caling: None such are protected by the copyright laws of the United States Office: (530) 534-9910 Fax: (530) 534-9915 SHEET DWG NAME Government. Reproduction of any of the above without written **ASPIRE** 9/28/2018 PAGE 7 OF 10 E-Mail:jim@tiledspas.com Web Site:www.tiledspas.com
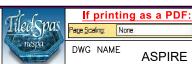
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TOTAL = 37.7 Sq Ft
POOL FLOOR **CONTACT AREA**
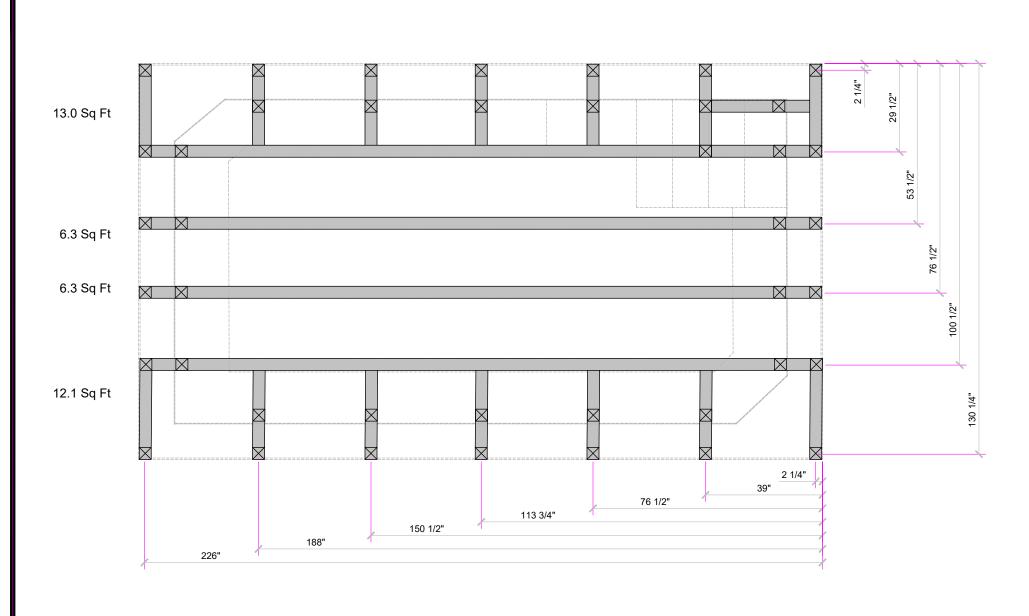
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SCALE 3/8" = 1'


1/4 1/2 3/4 1"


DWG TYPE SPA Skid Detail

DWG NAME **ASPIRE**

SHEET 12/7/2018

PAGE 1 OF 1

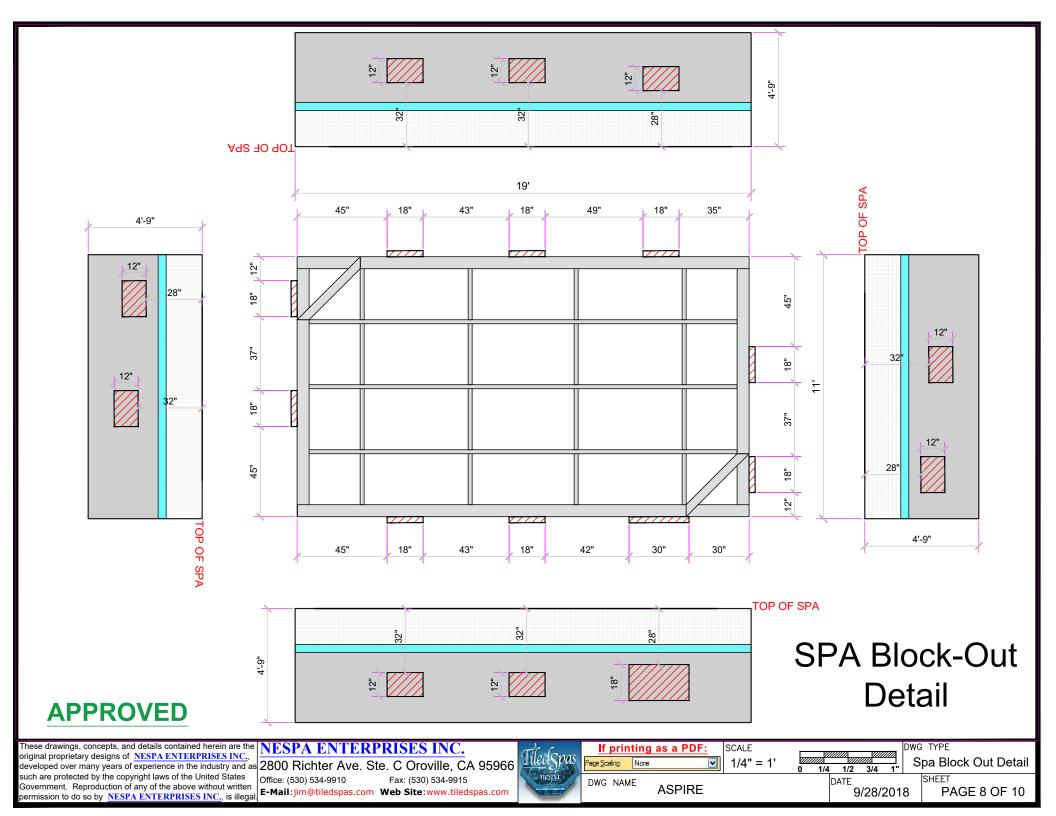

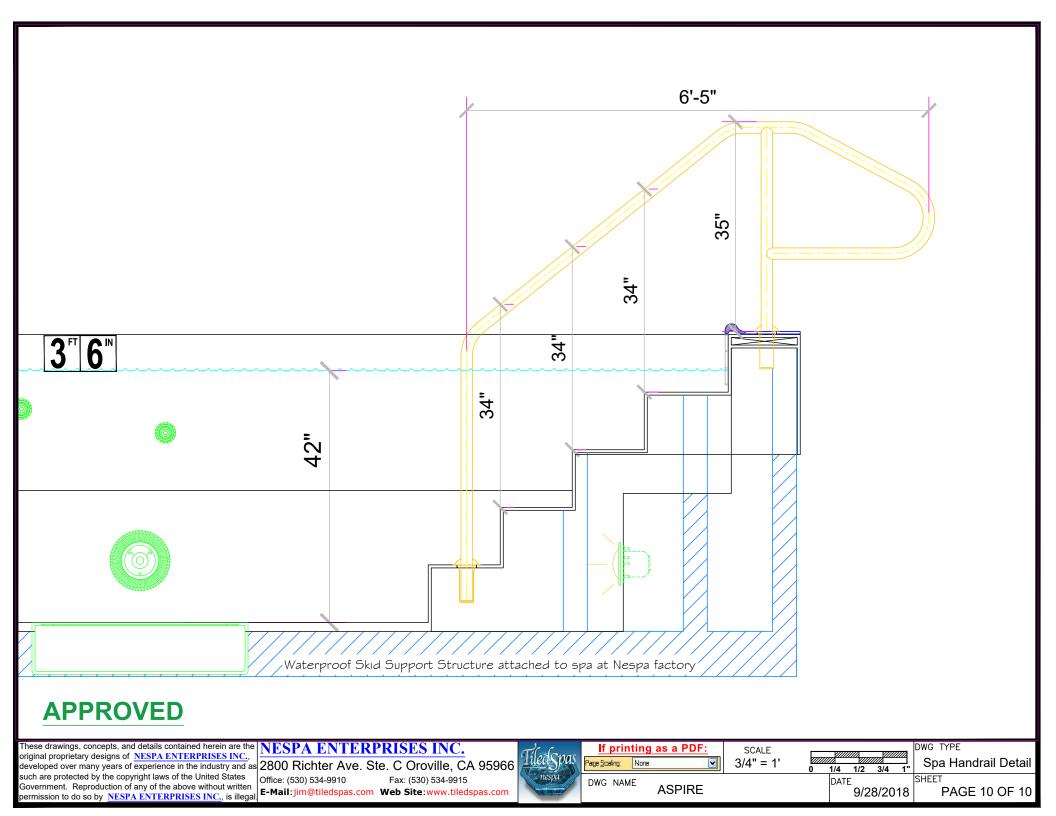

POOL DATA: Surface Area: 177.3 agit Table College: 1618 Tumeyer: 1.5 hour ion Flow R Filter eres 3.1 Sq.Pt. Alter mis: 13 gpm/sgit

POOL FITTINGS: (See Spa Drawing Submittel)

SPA DATA: Surface Area: 151.1 agit Istal Galloon: 2648 Turneyer: < 30 minutes Recircletion Flow Rate:

SPA FITTINGS: (See Spa Drawing Submittel)

Rottom Dudius: Sauch en: Zeech **Jet Studien well made** Let Returne: 15 mach

Spa Plumbing Velocity Calculation


TLIRV- True Linion Rall Value OH- Overhead Phunhi

MECHANICAL ROOM NOTES:

- 1. Provide 200 square inches of louvered vent for combustible air source for heater.
- 2. Provide gas line per manufacturer specifications. Install with sediment trap, gas cock and union
- 3. Anchor all equipment per manufacturer specifications. 4. Install all plumbing on the horizontal and vertical plane.
- 5. Support all plumbing with Superstrut supports and hangers.
- 6. Label all valves and plumbing. Install direction of flow arrews on plumbing.
- 7. Install new 1" pool and spa fill line via low voltage solenoid controlled by Leveler level centrol. Connect to approved back-flew prevention device.
- 3. Previde 1" conduit to "water closet" for low voltage sensor.
- 9. Provide 1" conduit for the pool and spe lights.
- 10. All equipment shall be NSF and UL listed as appropriate.
- 11. Connect all electrical equipment to GPCI circuits.
- 12. Use PVC, schedule 40 PVC unless otherwise directed in details.
- 13. Use Type III, Stainless steel vent for heater flue. Install to exterior of building per code or 8" double wall yent.
- 14 Gas supply line to be no less than 12" to mechanical.
- 15. Install ne more than 10" of 4" gas line to each heater. Install with sediment trap, union and gas valve for each heater. All other gas line shall be 1".
- 16. Provide no less than 190 sq. in. of open vent for exterior combustible air or provide dedicated 3" air supply from exterior of room. Instal per manufacturer's directions.
- 17. Provide 2:" air gap to backwash discharge standpipe

Pool & Spa Mechanical Room

Pool Plumbing Velocity Calculation

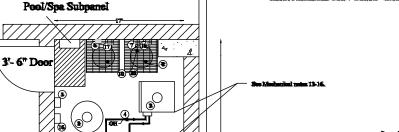

Poel Mechanical Equipment Schedule:

hen #	Builpment Description	Mentilleturer Medel #	Quantity	Payer/HP	Comments.
1	Pump	Pentair, Wispertie. WFB-4	1	1 PA 202 V	Install with Imp. Installer, yelves and yestum gauge. 40 (IPA 20 45 113)
3	High-Rate Send Pilter	Pechair, TR-60	1	NA.	Install with multipart bankwash valve and infloret/effloret presence gauges. Total There eyes: 3.4 St. Ft.
1	Pent Heater	Raypak	t	130/330V	His Jake 1914. Install you line wrings, unless and generals. Natural year. His in he 1° in within 45° of heater. Install fluorest millionie. Allielle, U.L. & NES
4	Play Mater	Play/Via	1	MA	Elpeannetions.
3	Chemical Controller	IPS, Name	1	130 V	Bust ORP act points, w/Resy cell, Bery sytich, taking and String package, in-line strainer Cartrals Begillering and sold Bader.
•	Chioritator	Steemer 453/55	t	1397	Reseives power from Chemical Controller. 10 - 30 GPD expanity.
7	Antil Pender	Stermer 459/5	1	130 A	Resolves power from Chemical Controller, 18-28 GPD separity.
*	Acid Veper Central	Veperabield 375	t	NA.	3/6" Tubing-semections.
9	Cantral	Loyellor	1	1 Phone, 1987	lank Day proyection device. But some the year should prove with approved
18:	Containment	Buje, M. z.M.	2	MA	One for Chlorine, One for soid. Shared by pool and spa.

Spa Mechanical Equipment Schedule:

#	Implement Description	Manuflaturer Model #		Payer/HP	Comments					
128	Residentation Pump	Pathic, Waperin	ı	2HP,2007	Install with trop, Installen volves and vacuum gauge. MCPAL@65 TDE					
13:	High-Rate Sand Filter	Pentals, TR-140C	1	NA.	Install with multipart backwark valve and influent/offloors pressure gauges. Take Other way: 7.55 for R.					
14	Post Heater	Repple	1	130/350Y	Market BTV. Install and the wines, under and prevent. Natural and lines to be 1" to within 48" of bester, install the new mileson. ADAR, LIL-10 NEP					
15.	Floy Motor	Ploy/Vis	t	NA.	Sipremetion.					
14.	Chemical Controller	11.27 170000	1	130 Y	Dual GRP art points, w/flow and, flow switch, taking and fitting pushage, in-line student, Controls the obligation and said basins.					
17	Chierinster	Sterner 450/55.	1	130 Y	Receives power them Chemical Controller. 18 to 50 GPD especity.					
津	Ásid Reeder	Stenner 453/45	1	130 Y	Reserves power from Chemical Controller. 10 to 50 GPD especity.					
13:	Jet Boost Pump	Pentalt Wispertie- HKK-12	1	8 200	man was man harden way and was an age of the company and affect for a 190 CFM 20 TOH					
20	Shut-Off	Petral LX-400	1	- // // · · ·	Install with the making paint factors which which 15 has of spa. To man off both recollection and spa baset pump.					
Ħ	Loyel Cantrol	Loyder	1	1 Phone, 130 y	Comment to largy vallege answer and 1" largy vallege animonal valve with approprial bank flow provention device. Set answer in water closet adjacent one with Bank life.					
*	Add Vapor	Veperatibile 373	1	NA.	MFTubing connections					

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Stair well

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SCALE N/A

DWG TYPE Mechanical Layout


1/4 1/2 SHEET


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DWG NAME

BONDING DETAIL

TYPICAL NESPA SHELL CUP **Anchor Installation**



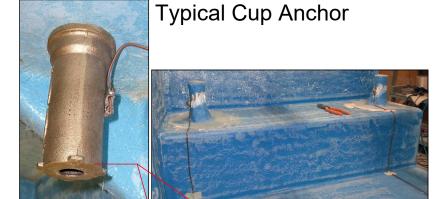

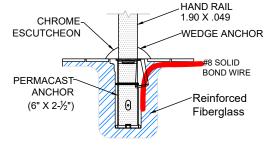NOTE:


DETAIL REFLECTS ANCHOR INSTALLATION IN NESPA SHELLS ONLY.

CUP ANCHOR SHALL BE BONDED WITH A SOLID #8 COPPER BOND WIRE AND VERIFIED BY A CALIFORNIA LICENSED ELECTRICAL CONTRACTOR.


BOND WIRE WILL BE ENCASED AND COVERED IN FIBERGLASS TO PREVENT WATER LEAKAGE THRU SHELL.

BOND WIRE SHALL EXIT AT EDGE OF SPA AND ATTACH TO DECK BONDING GRID.



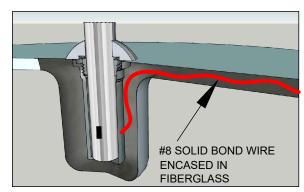


DWG NAME

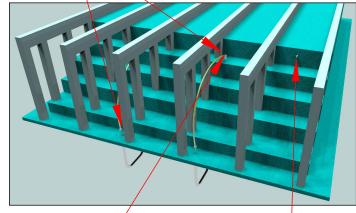





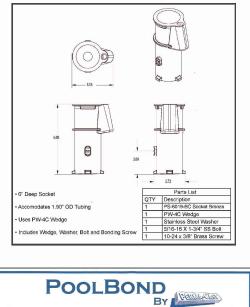

PS-6019-BC

6 Inch Big Boy Socket

PATILLE CHES

Swimming Pool Products




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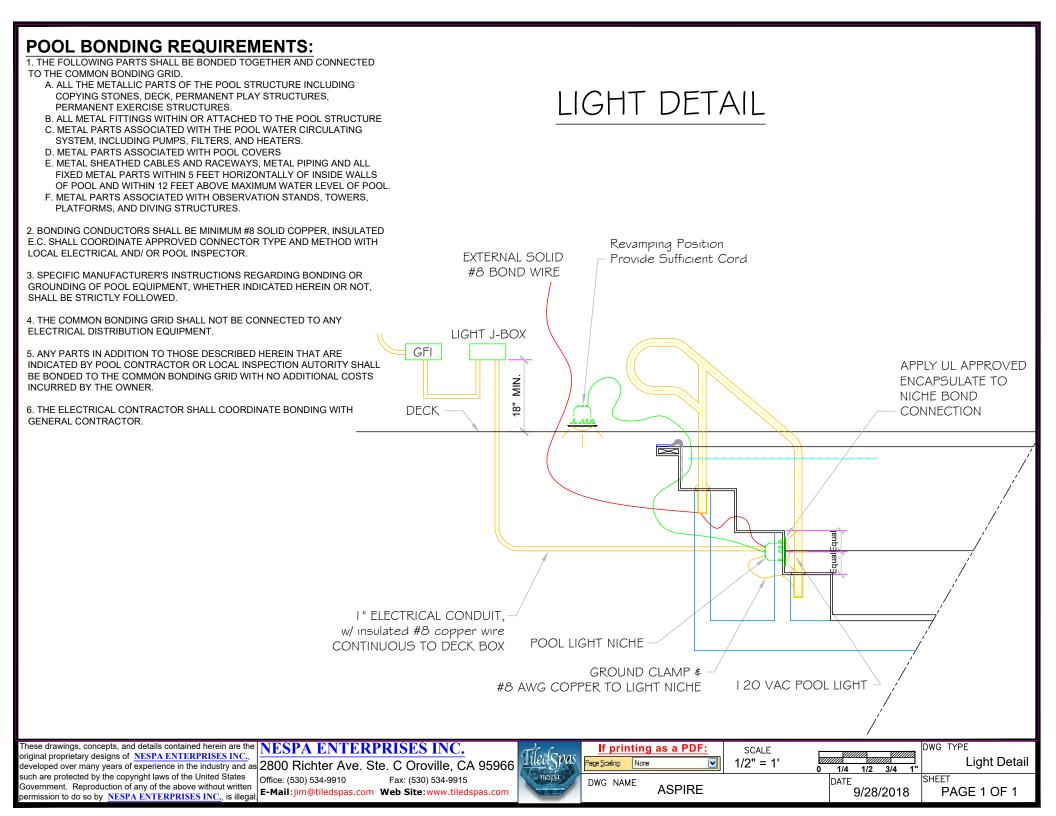
1/4 1/2 3/4


DWG TYPE **Bonding Detail**


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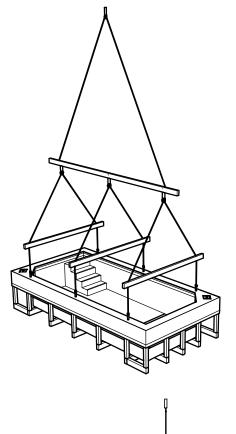
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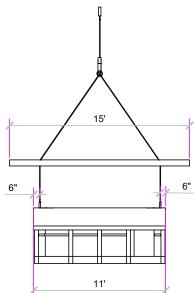
SHEET PAGE 1 OF 1




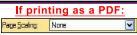



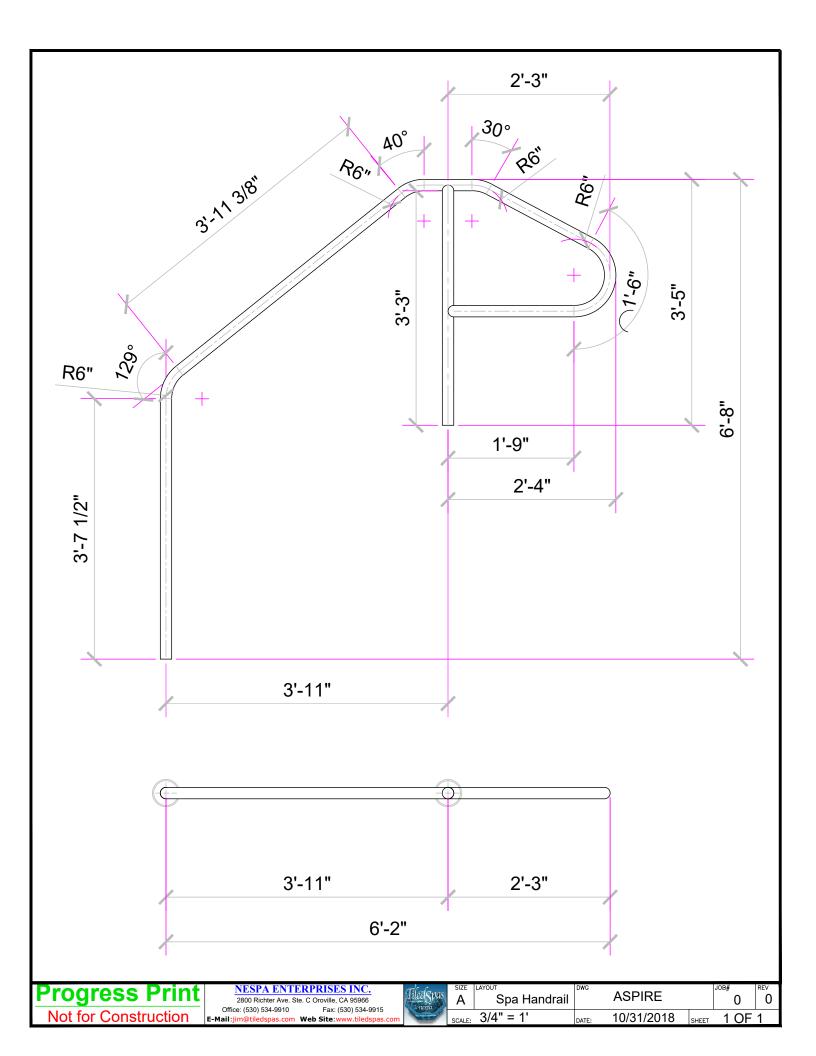


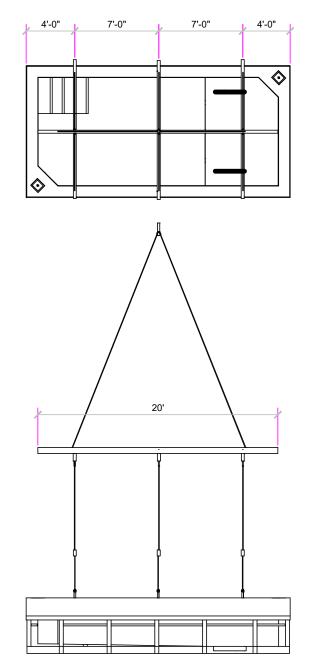

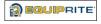

Forged Eye Bolt, Plain Pattern, (includes nut), Hot Dip Galvanized

The information below lists the required dimensional, chemical and physical characteristics of the products in this purchase order. If
the order received does not meet these requirements, it may result in a supplier corrective action request, which could peopardize your
status as an approved vendor. Unless otherwise specified, all referenced consensus standards must be adhered to in their entirety.

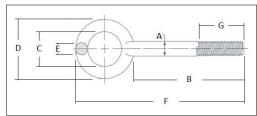

		A	В		С		D	E		F		G	Working	
Normal Size		ank neter	Shank	length	Eye	e ID	Eye OD		ection neter	OAL		Thread Length	Load Limit (lb)	
	Max.	Min.	Max.	Min.	Max.	Min.	Nom.	Max.	Min.	Max.	Min.	Min.	Max.	
3/4 x 6	0.82	0.73	6.12	5.88	1.54	1.48	2.99	0.79	0.71	9.31	9.07	2.99	5200	

Specification Requirements:

· Dimensions: See Table Above

· Material: Carbon Steel per ASTM A489

Thread Requirements: ASME B1.1 UNC & UNRC, Class 1A before coating.


Marking:
 Finish:

Country or Origin, Manufacturer's ID and WLL Hot Dipped Galvanized per ASTM A153 Class B1 or F2329

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DWG NAME

SCALE 1/8" = 1'

1/4 1/2 3/4 1

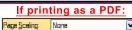DWG TYPE

Lift Detail

SHEET DATE

PAGE 1 OF 1

ASPIRE

10/31/2018

STANDARD NESPA IN-GROUND INSTALLATION INSTRUCTIONS SET-UP AND EXCAVATION

Prerequisites: Before installing your Nespa spa. You may be required to acquire a permit from your local State, County, and City building dept and or Health department. (Commercial jobs need Health Dept. Approval). Your spa installation must comply with the most current codes. (Uniform Swimming Pool, Spas & Hot Tub Code 2006 (USPC 2006).

Spa drawings: Request from Nespa a current spa specific construction detail, plan and section, spa plumbing detail.

Delivery Access: Clearly determine the method of getting the spa to jobsite and into the hole. This may require the use of a crane, forklift, hoist, backhoe and/or manpower etc.

- 1) The following instructions are general guidelines and may not apply to your specific jobsite conditions. When excavating for your spa remember to provide for plumbing and light connection clearances. In order to determine how to excavate for your spa or swim spa, measure spas outside dimension (O.D.) and add minimum 3" to all sides. This 3" clearance is to accommodate jet and suction plumbing. This 3"clearance can change or be reduced upon request. Note: skimmer location, this area may have to be larger than 3", if commercial 22".
- 2) Freeze Climates- If the spa is place into a vault (typical of freeze climates) a standard 18" or more of clearance minimum from spa perimeter should be provided. This dead air space is for possible future access to spa plumbing in case of a freeze. Area drain is mandatory. Ask your local installer for his experienced opinion. Do not hesitate to call us because we want to be sure that your installation progresses as smoothly as possible. If you have questions call us. (888) 479-4677.
- 2) **Hole depth** is determined by spa's outside height dimension. This height may vary depending if spa has skids or no skids. The spa lip may be finished or non-finished. How is the perimeter deck elevation transitioning to the spa? Focus on the finish surrounding deck elevations, thickness of the finish material on spa upper horizontal lip, equal to lip or under the spa lip. This material can be tile, stone, concrete or brick.
- 3) **Preplumb** the spa before it goes into the hole. If there are needs for electrical, bonding or control conduits run them as well before dropping in hole. Connect bond wire to niche would be best.
- 4) Spa should sit on level 3 ½" thick reinforced concrete pad. Sweep debris off pad prior to dropping in hole.
- 5) **Install spa** into the hole on top of concrete pad. Use the Eye bolts provided for crane, forklift etc. rigging. Do not hold onto pipes. Use caution with suction and jet plumbing when lowering into hole. DO NOT STRESS FITTINGS! Fill Spa with water and check for leaks prior to backfill.

- 6) Check site reference points for proper spa positioning (i.e., squaring to house, garage, etc.).
- 7) **Shim to level spa**. Shim with non-compression able material. Re square to house, or ref. point.
- 8) Dry pack with cement the gaps that have been created when shimming spa level.
- 9) **Connect pipes to tees** if spa is preplumb. Installers properly support your new plumbing from stressing spas preplumb fittings. After electrical conduit and bond wire is connected to light niche, water test spa before back filling with sand.

NOTE: All Nespa products are water tested prior to leaving factory.

ELECTRICAL:

- 1) All electrical connections to spa or equipment should comply with the most recent national electrical code (NEC), state and local codes.
- 2) Connect electrical conduit to light niche. This work should be done or reviewed by a licensed electrician.
- 3) To install spa light you will need to include inside the PVC conduit to the light niche a solid #8 coated copper wire. (If you are use brass conduit, internal bond wire is not required.) This bond wire should be pulled with the light cord at the same time. This bond wire needs to be attached to the internal bonding lug of the light niche. An approved encapsulate should be applied to bond wire connection in niche.
- 4) An external #8 copper wire shall be connected to the external bonding lug on the rear of the light niche. This copper wire can then be used for additional bonding requirements (i.e., handrails or any other metallic object within 5' of the spa.

PLUMBING:

- 1) When plumbing a Nespa it is important to properly size the plumbing. We highly recommend that you follow the pump manufacturer's pipe sizing requirements and Uniform Swimming Pool, Spas & Hot Tub Code 2006 (USPC 2006). This code book is available at www.IAPMO.org or (909) 472 4100.
- 2) The jet air venturi should be a Hartford loop design adjacent to spa shell and air entry point can be located next to spa or remotely at equipment.
- 3) Fill spa with water and test the system for leaks PRIOR to backfilling with sand.

SAND BACK FILL:

- 1) With water in spa, back-fill around spa perimeter with dry plaster sand and wet wash with hydraulic attachment to hose. Let set for one hour and hydraulic dry again. Be sure water level in spa is at the highest level. Any questions please call us. (888) 479-4677.
- 2) If spa is free standing on elevated deck or a structure, it is important to fill spa with water and load area prior to installing coping or perimeter decking. If spa is installed in a vault situation a area drain is needed.

NESPA ENTERPRISES INC.

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IN-GROUND

INSTALLATION


ALL DIMENSIONS SUBJECT TO 1/4" TOLERANCES

SCALE: 1/2" = 1'-0"

DATE: 3/27/02

JOB: STANDARD INSTALL


DW #: SI-1, SI-2

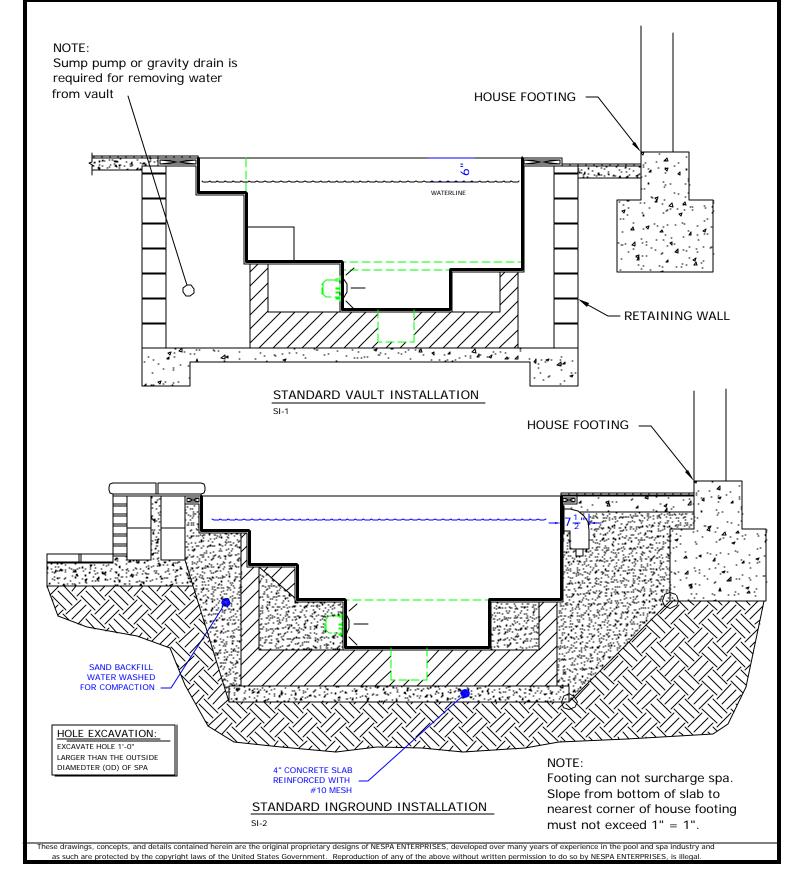

POOL BONDING REQUIREMENTS:

- 1. THE FOLLOWING PARTS SHALL BE BONDED TOGETHER AND CONNECTED TO THE COMMON BONDING GRID.
 - A. ALL THE METALLIC PARTS OF THE POOL STRUCTURE INCLUDING COPYING STONES, DECK, PERMANENT PLAY STRUCTURES, PERMANENT EXERCISE STRUCTURES.
 - B. ALL METAL FITTINGS WITHIN OR ATTACHED TO THE POOL STRUCTURE
 - C. METAL PARTS ASSOCIATED WITH THE POOL WATER CIRCULATING SYSTEM, INCLUDING PUMPS, FILTERS, AND HEATERS.
 - D. METAL PARTS ASSOCIATED WITH POOL COVERS
 - E. METAL SHEATHED CABLES AND RACEWAYS. METAL PIPING AND ALL FIXED METAL PARTS WITHIN 5 FEET HORIZONTALLY OF INSIDE WALLS OF POOL AND WITHIN 12 FEET ABOVE MAXIMUM WATER LEVEL OF POOL.
 - F. METAL PARTS ASSOCIATED WITH OBSERVATION STANDS, TOWERS, PLATFORMS, AND DIVING STRUCTURES.
- 2. BONDING CONDUCTORS SHALL BE MINIMUM #8 SOLID COPPER, INSULATED E.C. SHALL COORDINATE APPROVED CONNECTOR TYPE AND METHOD WITH LOCAL ELECTRICAL AND/ OR POOL INSPECTOR.
- 3. SPECIFIC MANUFACTURER'S INSTRUCTIONS REGARDING BONDING OR GROUNDING OF POOL EQUIPMENT, WHETHER INDICATED HEREIN OR NOT, SHALL BE STRICTLY FOLLOWED.
- 4. THE COMMON BONDING GRID SHALL NOT BE CONNECTED TO ANY ELECTRICAL DISTRIBUTION EQUIPMENT.
- 5. ANY PARTS IN ADDITION TO THOSE DESCRIBED HEREIN THAT ARE INDICATED BY POOL CONTRACTOR OR LOCAL INSPECTION AUTORITY SHALL BE BONDED TO THE COMMON BONDING GRID WITH NO ADDITIONAL COSTS INCURRED BY THE OWNER.
- 6. THE ELECTRICAL CONTRACTOR SHALL COORDINATE BONDING WITH GENERAL CONTRACTOR.

LIGHT DETAIL

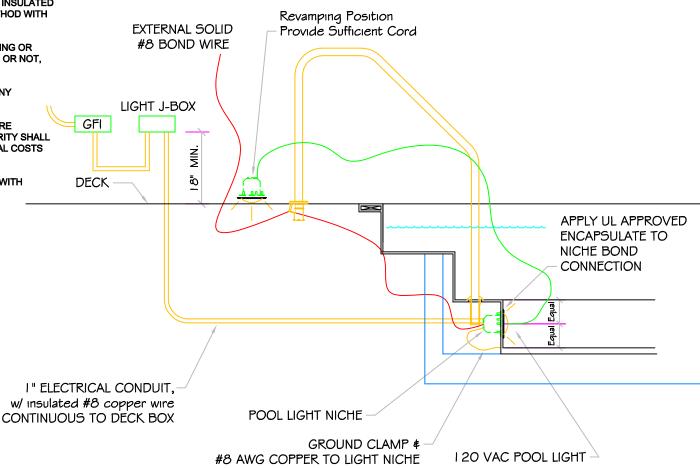

ALL DIMENSIONS SUBJECT TO 1/4" TOLERANCES

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SIZE Α

DWG NAME

DETAILS

DWG TYPE Detail

SCALE 1/2" = 1"

DATE 7/24/2008

SHEET

PAGE 1 OF 1

NESPA ENTERPRISES, Inc. LIMITED WARRANTY

This LIMITED WARRANTY covering NESPA products is extended to the ORIGINAL PURCHASER-USER BY NESPA ENTERPRISES Inc.(NESPA), 2800 Richter Ave. Unit C California 95966.

NESPA products are thoroughly inspected and tested prior to factory shipment. NESPA warrants to the ORIGINAL PURCHASER-USER that NESPA Spas and Swim Spas will be free of defect in workmanship, accessories and parts, provided said accessories and parts were manufactured by NESPA. NESPA, under this LIMITED WARRANTY, warrants only that its Spas and Swim Spas shall be structurally sound, shall retain their shape, and shall retain water for the warranty period. NESPA warrants the adhesion of tile to fiberglass for a period of three (3) years and structural soundness for ten (10) years. NESPA warrants epoxy grout adhesion for a period of three years. If any such defects appear and are reported within the warranty period, NESPA shall repair or replace such defective parts without charge if an inspection proves the claim.

The provisions of the LIMITED WARRANTY shall not apply to tile cracked, split, chipped or damaged after the product has left the factory, nor damage to tile caused by freezing nor to damage, defect, malfunction or failure to conform with the above warranty provisions where the damage, defect, malfunction or failure to conform was caused during shipment or by distributor or by unreasonable use by ORIGINAL PURCHASER-USER including improper water balance and improper sand pack or support.

This LIMITED WARRANTY shall not apply to any plumbing, equipment, or installation of spas and Swim Spas and shall not apply to any alterations made to or upon NESPA products except alterations made by NESPA employees or NESPA authorized representatives.

This LIMITED WARRANTY is expressly in lieu of all other warranties expressed or implied including the warranties of merchantability and fitness for use and all other obligations or liabilities on NESPA'S part, and NESPA neither assumes nor authorizes any other person to assume for NESPA any other liability in connection with the sale of this NESPA product. This LIMITED WARRANTY shall not apply to this NESPA product or any part thereof which has been subject to accident, negligence, alteration, abuse or misuse. NESPA makes no warranty whatsoever with respect to accessories or parts not manufactured by NESPA.

The term "ORIGINAL PURCHASER-USER" as used in this LIMITED WARRANTY shall be deemed to mean that person for whom the NESPA product is originally installed.

The LIMITED WARRANTY provided herein and the obligations and liabilities of NESPA hereunder are exclusive and are in lieu of, and buyer and original PURCHASE-USER hereby waive all other remedies, warranties, guarantees or liabilities, expressed or implied, arising by law or otherwise (including without limitation and obligations of NESPA with respect to fitness, merchantability, and consequential damages) or whether or not occasioned by NESPA'S negligence.

This LIMITED WARRANTY shall not be extended, altered or varied except by a written instrument signed by NESPA and original PURCHASER-USER.